


This work was performed by me or under my supervision and construction of this project will be under my observation (observation of construction as defined in section 16-115.2 of the rules and regulations of the Board of Professional Engineers, Architects and Surveyors of the State of Hawaii).

Duncan P. McClelland, AIA
Architect License No. 15148, Expires 4/30/2010


Add. No.	Description of Revision	Date

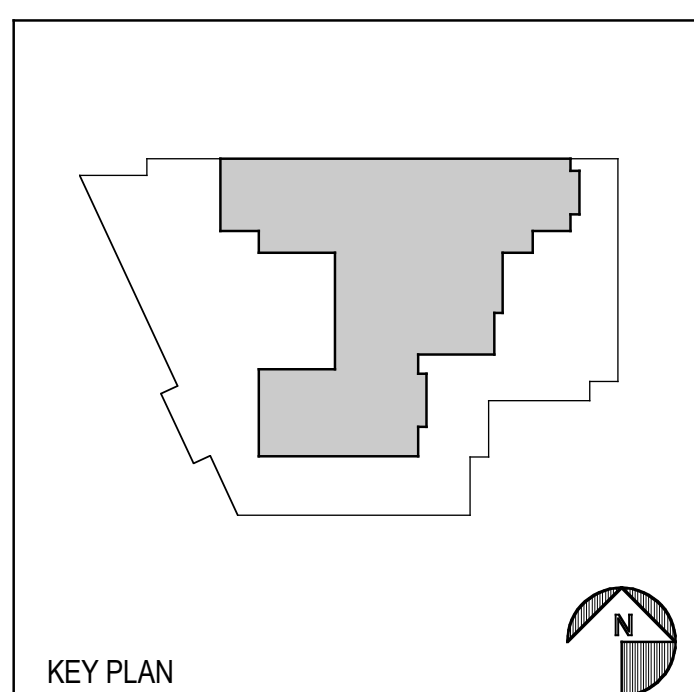

FLOOR PLAN

Drawn by: BF & CB Job Number: 2804.00
Checked by: CB Scale: 1/4" = 1'-0"
Plot Date: 27 MAR 2009 Issue Date: 27 MAR 2009

REVISED PERMIT DRAWINGS **A 1.1**

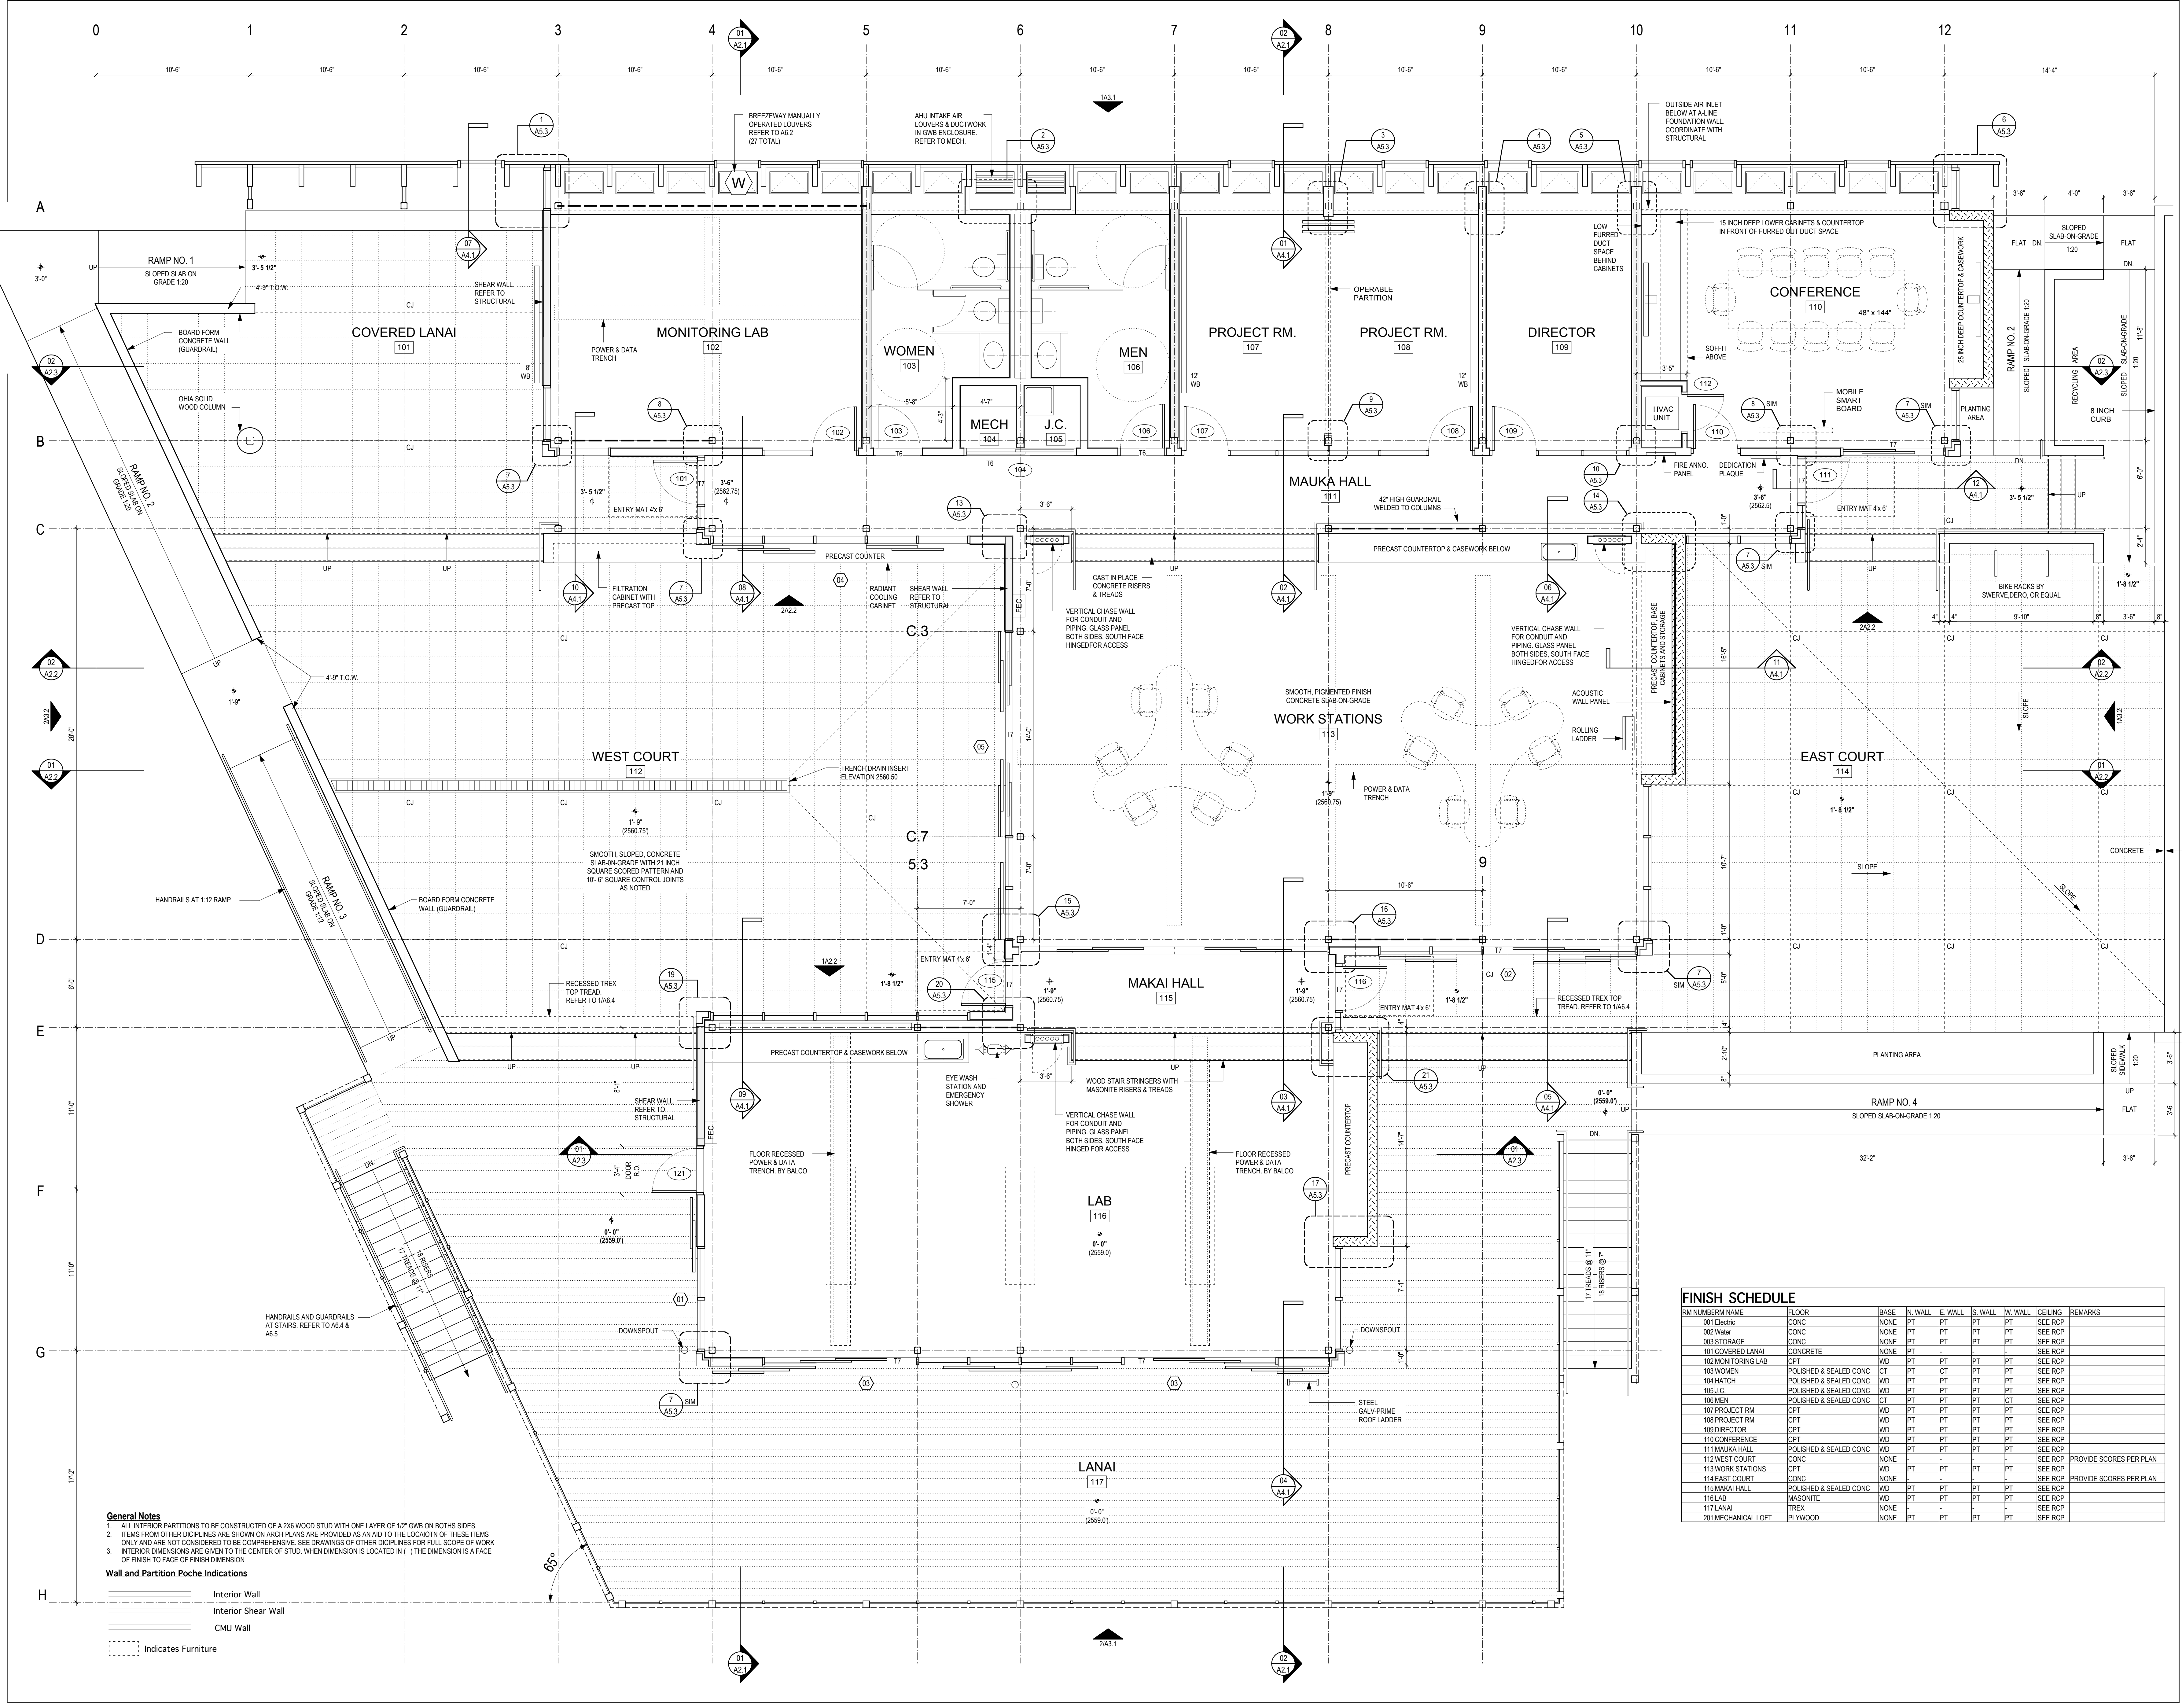

FINISH SCHEDULE

RM NUMBER	NAME	FLOOR	BASE	N WALL	E WALL	S WALL	W WALL	CEILING	REMARKS
001	ENERGY LAB		CONC	PT	PT	PT	PT	PT	SEE RCP
002	WAY		CONC	NONE	PT	PT	PT	PT	SEE RCP
003	STORAGE		CONC	NONE	PT	PT	PT	PT	SEE RCP
101	COVERED LANAI		CONCRETE	NONE	PT	PT	PT	PT	SEE RCP
102	MONITORING LAB		CPT	WD	PT	PT	PT	PT	SEE RCP
103	WOMEN		POLISHED & SEALED CONC	CT	PT	CT	PT	PT	SEE RCP
104	HATCH		POLISHED & SEALED CONC	WD	PT	PT	PT	PT	SEE RCP
105	J.C.		POLISHED & SEALED CONC	WD	PT	PT	PT	PT	SEE RCP
106	MEN		POLISHED & SEALED CONC	CT	PT	PT	PT	PT	SEE RCP
107	PROJECT RM		CPT	WD	PT	PT	PT	PT	SEE RCP
108	PROJECT RM		CPT	WD	PT	PT	PT	PT	SEE RCP
109	DIRECTOR		CPT	WD	PT	PT	PT	PT	SEE RCP
110	CONFERENCE		CPT	WD	PT	PT	PT	PT	SEE RCP
111	MAUKA HALL		POLISHED & SEALED CONC	WD	PT	PT	PT	PT	SEE RCP
112	WEST COURT		CONC	NONE	-	-	-	-	SEE RCP
113	WORK STATIONS		CPT	WD	PT	PT	PT	PT	PROVIDE SCORES PER PLAN
114	EAST COURT		CONC	NONE	-	-	-	-	SEE RCP
115	MAKAI HALL		POLISHED & SEALED CONC	WD	PT	PT	PT	PT	SEE RCP
116	LAB		MASONITE	WD	PT	PT	PT	PT	SEE RCP
117	LANAI		TREX	NONE	-	-	-	-	SEE RCP
201	MECHANICAL LOFT		PLYWOOD	NONE	PT	PT	PT	PT	SEE RCP

- General Notes**
- ALL INTERIOR PARTITIONS TO BE CONSTRUCTED OF A 2X6 WOOD STUD WITH ONE LAYER OF 1/2" GWS ON BOTH SIDES
 - ITEMS FROM OTHER DISCIPLINES ARE SHOWN ON ARCH PLANS AND TO THE LOCATION OF THESE ITEMS ONLY AND ARE NOT CONSIDERED TO BE COMPREHENSIVE. SEE DRAWINGS OF OTHER DISCIPLINES FOR FULL SCOPE OF WORK
 - INTERIOR DIMENSIONS ARE GIVEN TO THE CENTER OF STUD. WHEN DIMENSION IS LOCATED IN () THE DIMENSION IS A FACE OF FINISH TO FACE OF FINISH DIMENSION
- Wall and Partition Poche Indications**
- Interior Wall
 - Interior Shear Wall
 - CMU Wall
 - Indicates Furniture