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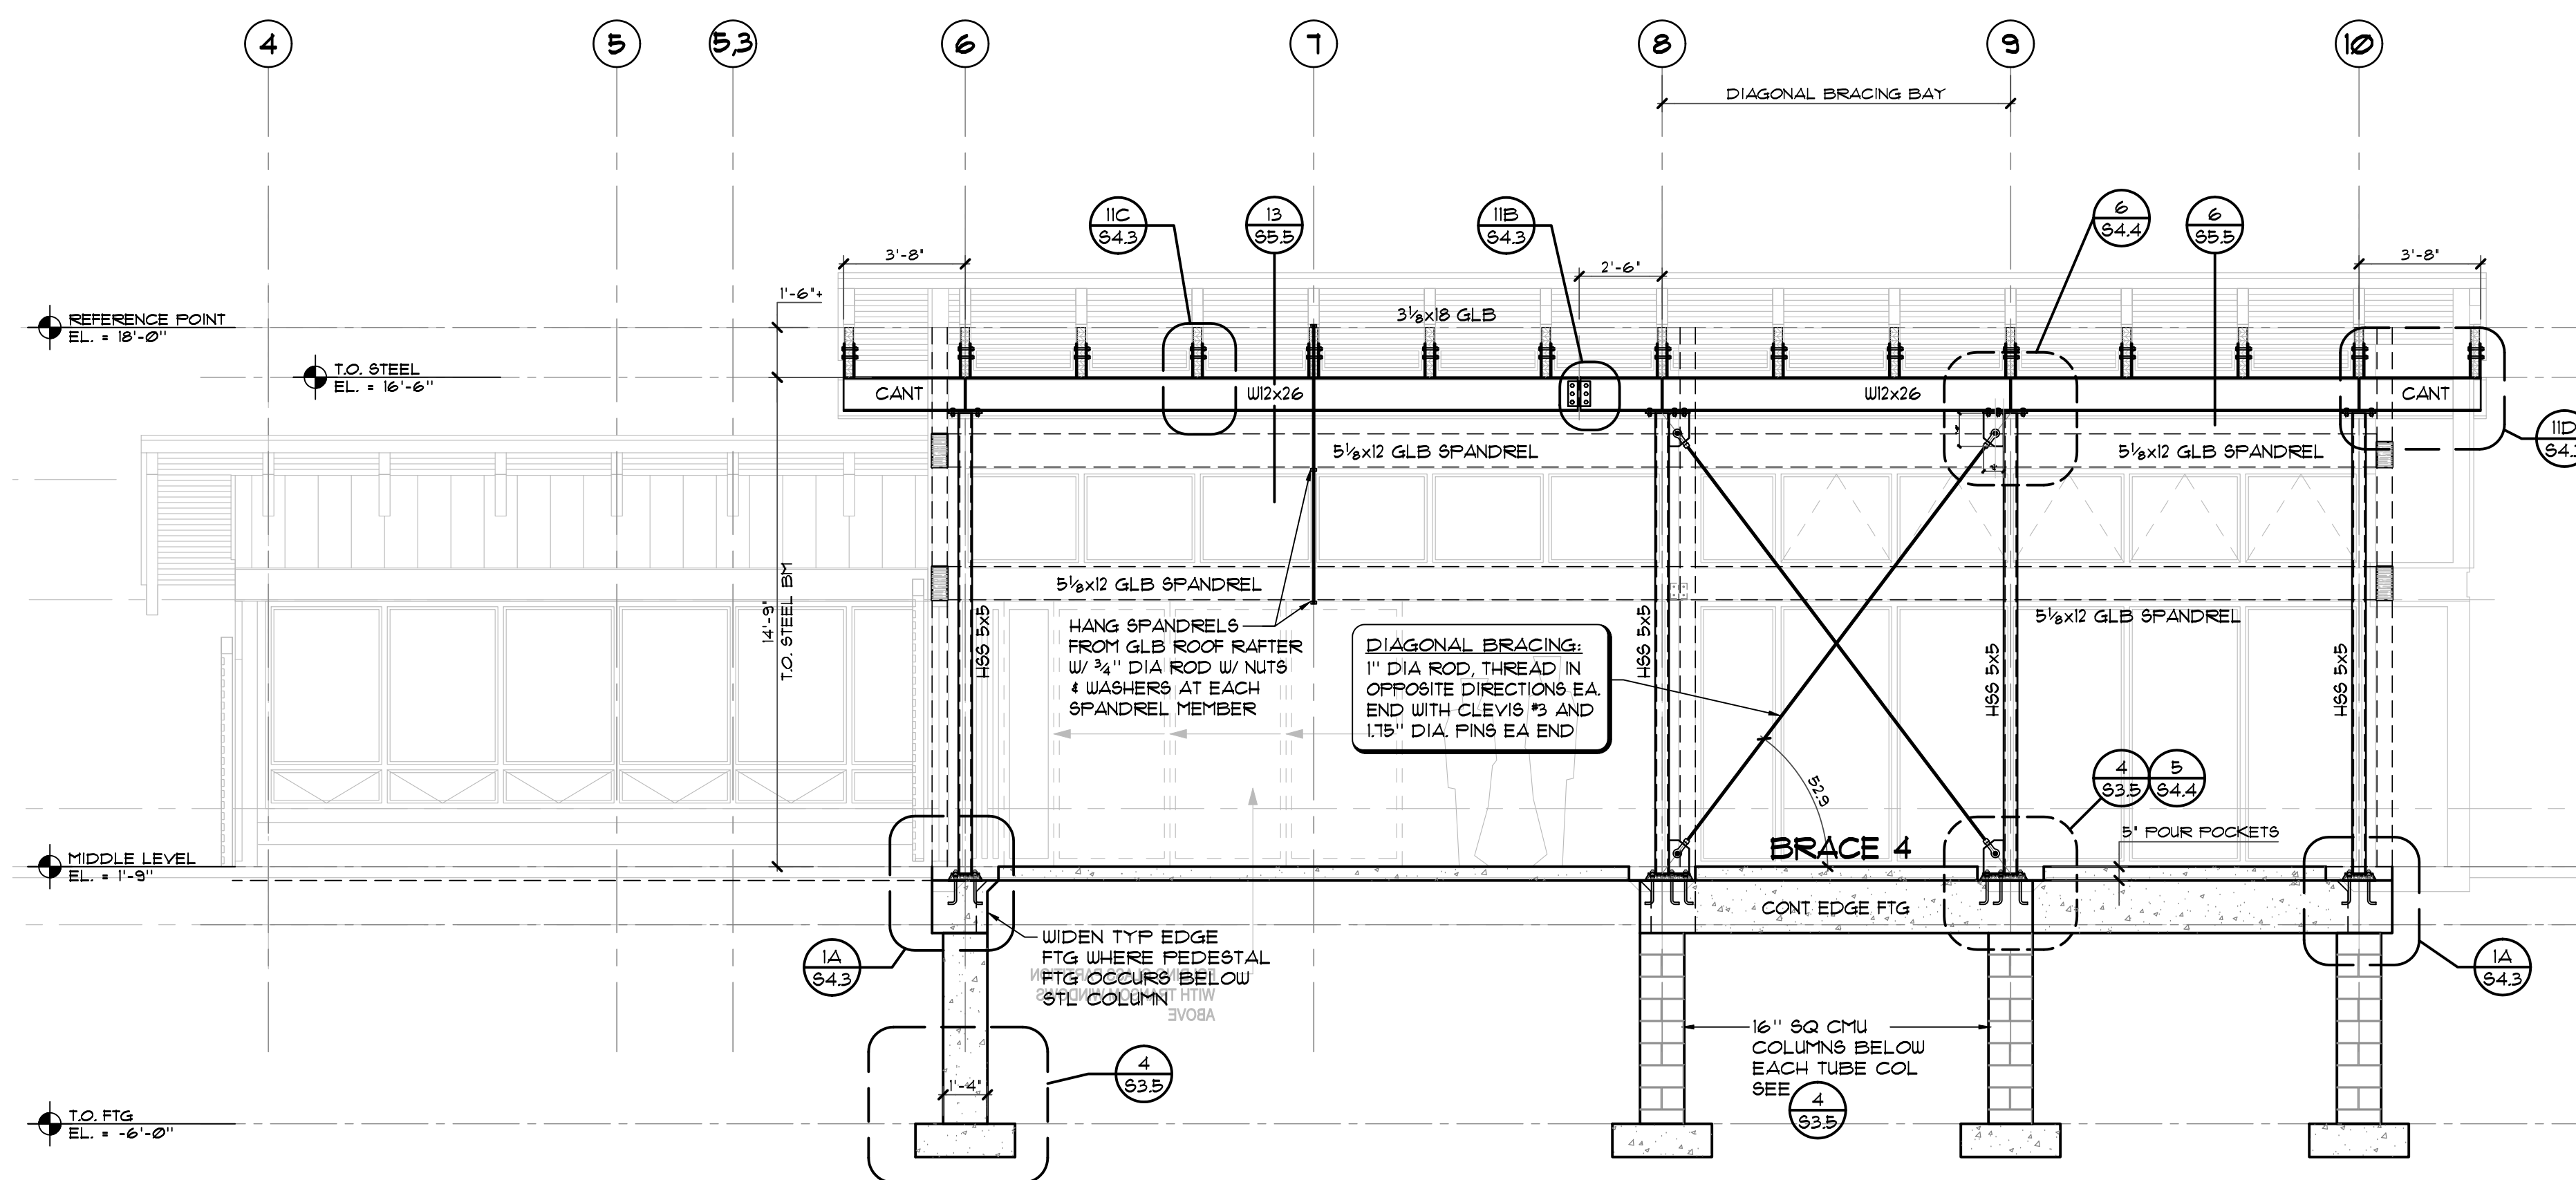
STRUCTURAL ENGINEERING
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MECHANICAL ENGINEERING
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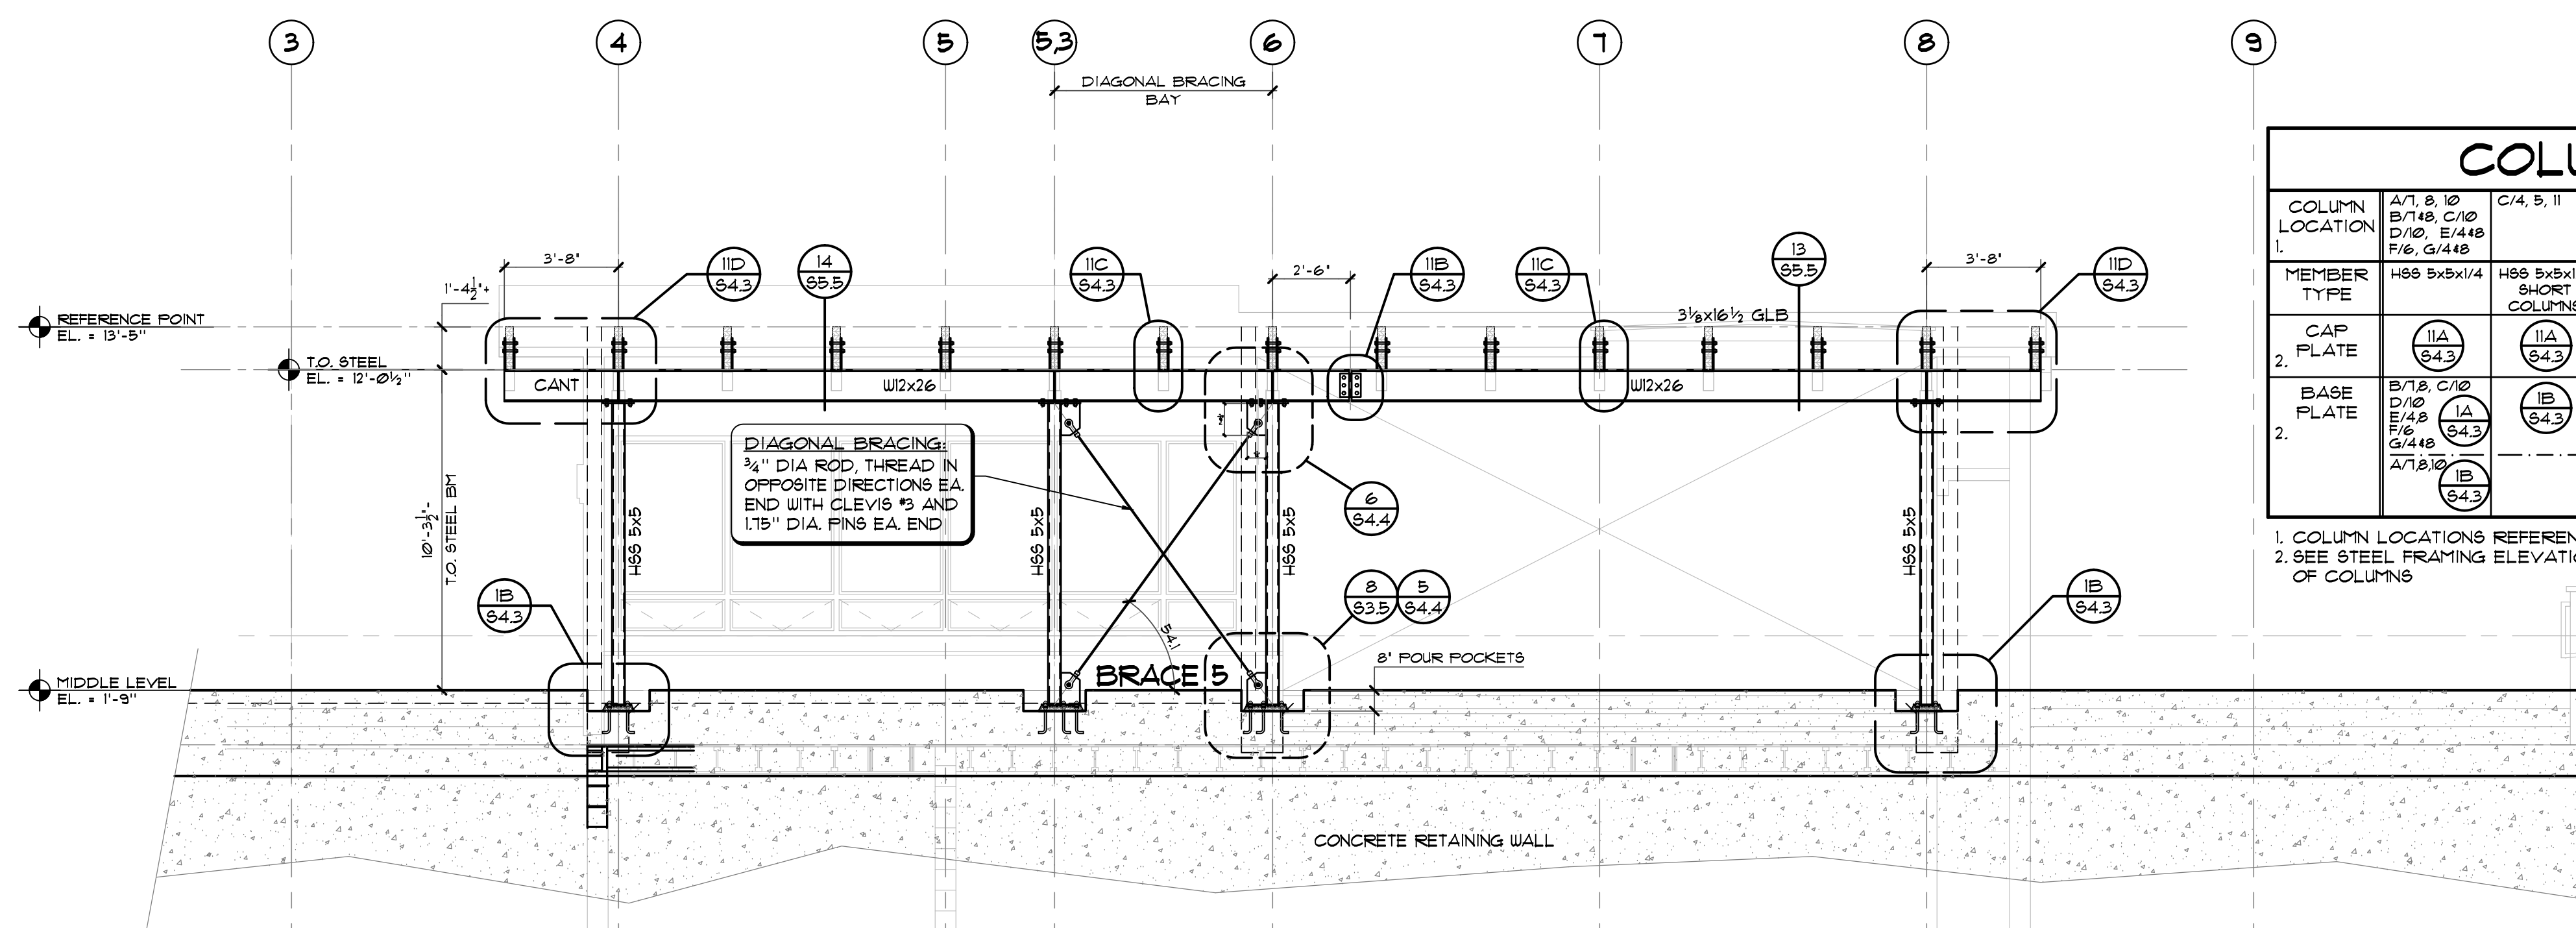
ELECTRICAL ENGINEERING
Wallace T. Oki, PE, Inc.



This work was performed by me or under my supervision and construction of this project will be under my direction (Observation of construction as defined in section 12-115-2 of the rules and regulations of the Board of Professional Engineers, Architects and Surveyors of the State of Hawaii).
EVT 4/26/2010




3 FRAMING ELEVATION: STRUCTURAL STEEL FRAMING
ELEVATION ALONG GRID LINE **D**
SCALE: 1/4" = 1'-0"




2 FRAMING ELEVATION: STRUCTURAL STEEL FRAMING
ELEVATION ALONG GRID LINE **E**
SCALE: 1/4" = 1'-0"

COLUMN SCHEDULE									
COLUMN LOCATION	A/1, B/10	C/4, B/11	A/3/4, B/3/4	B/5, 6, 10/11	C/3/6, C/8/8	A/2, B/2	A/1		
MEMBER TYPE	HSS 8x8x1/4 B/1/8, C/8/8 D/2, E/4/4 F/6, G/4/4	HSS 8x8x1/4 SHORT COLUMNS	HSS 8x8x1/2 BRACED FRAME	HSS 8x8x1/2	HSS 8x8x1/2 SPANDREL SUPPORT	HSS 6x6x3/8	HSS 6x4x3/8 WIND COLUMN		
CAP PLATE	I/A S4.3	I/A S4.3	I/A S4.3	I/A S4.3	I/A S4.3	I/A S4.3	I/A S4.3	I/A S4.3	I/A S4.3
BASE PLATE	B/1/8, C/1/8 D/2, E/4/4 F/6, G/4/4 H/8, I/8/8	I/A S4.3	I/B S4.4	B/5, 6 B/10/11 C/6	I/A S4.3	I/A S4.3	I/C S4.3	I/D S4.3	I/D S4.3

1. COLUMN LOCATIONS REFERENCE GRID LINE INTERSECTIONS
2. SEE STEEL FRAMING ELEVATIONS ON SHEET S4.1 & 4.2 FOR HEIGHTS AT TOP & BOTTOM OF COLUMNS

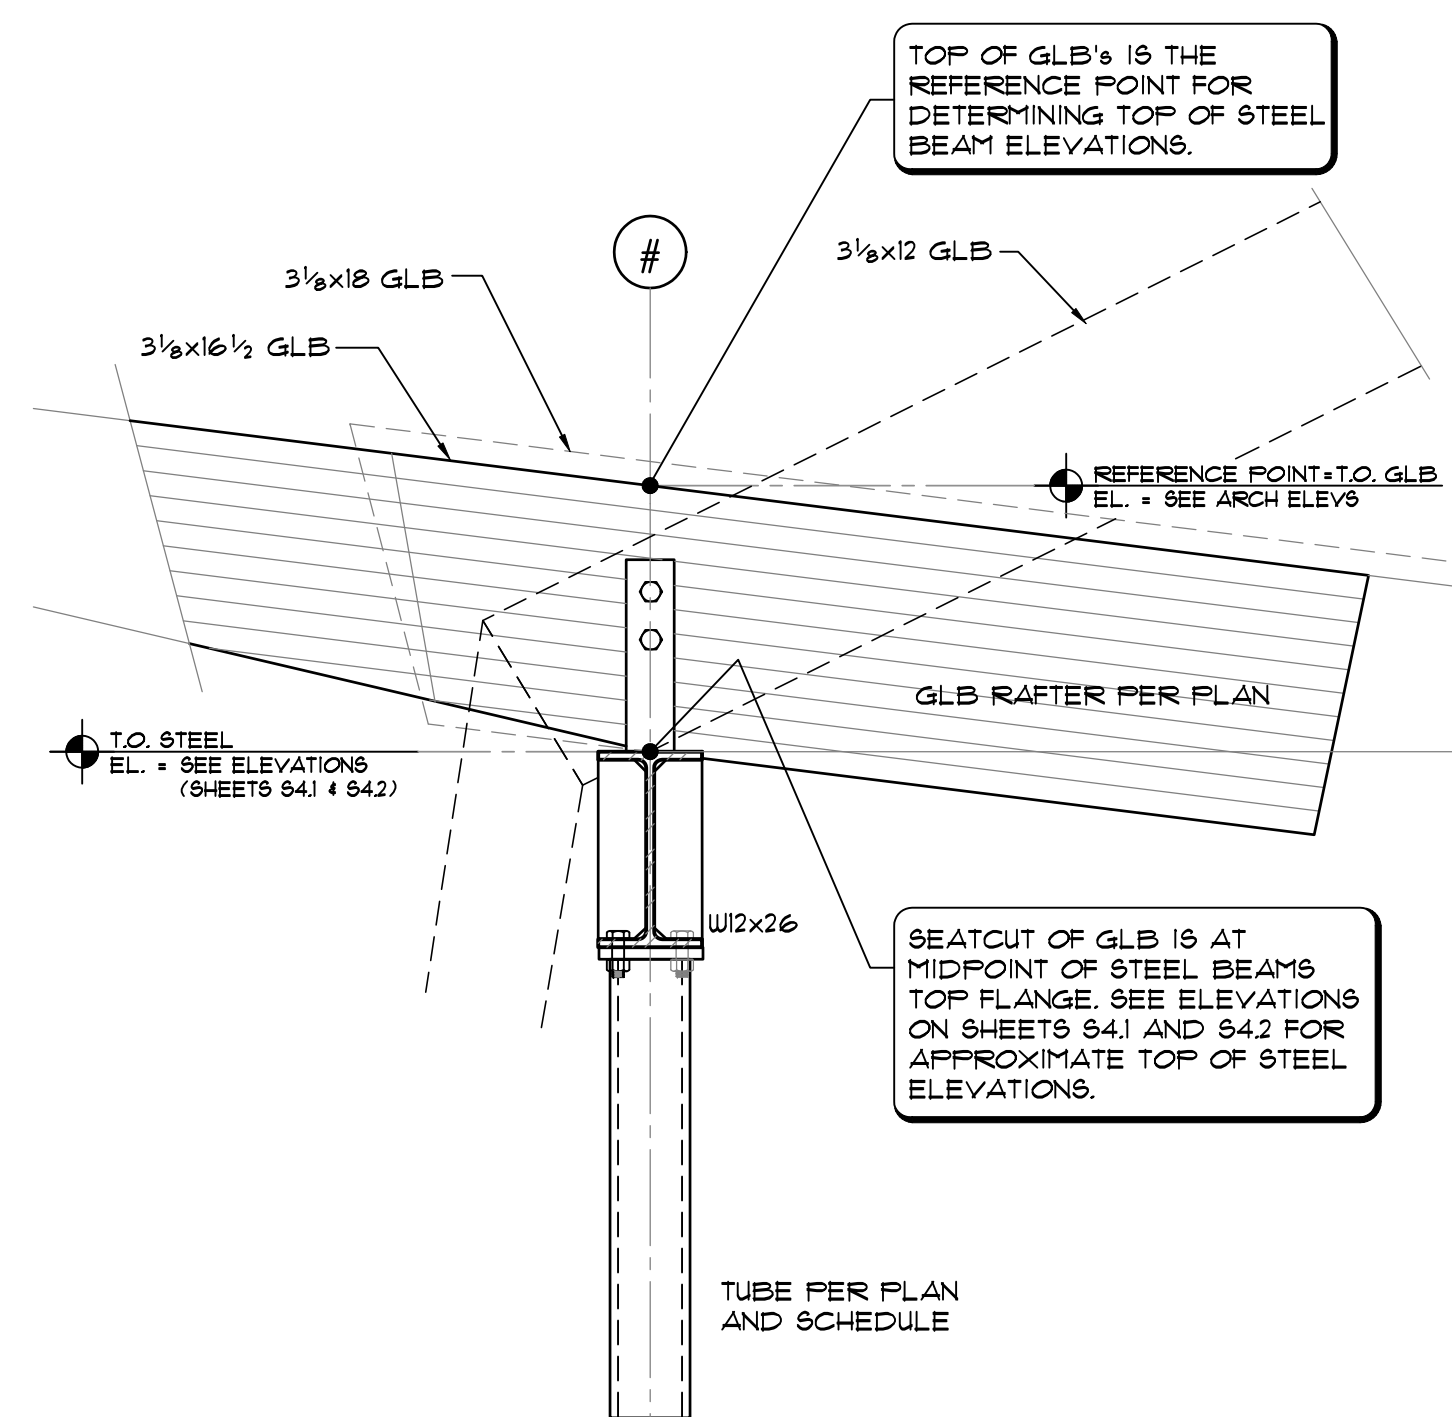

15 FRAMING DETAIL: TOP OF STEEL BEAM ELEVATIONS
SCALE: 1" = 1'-0" REFERENCE POINT INFORMATION

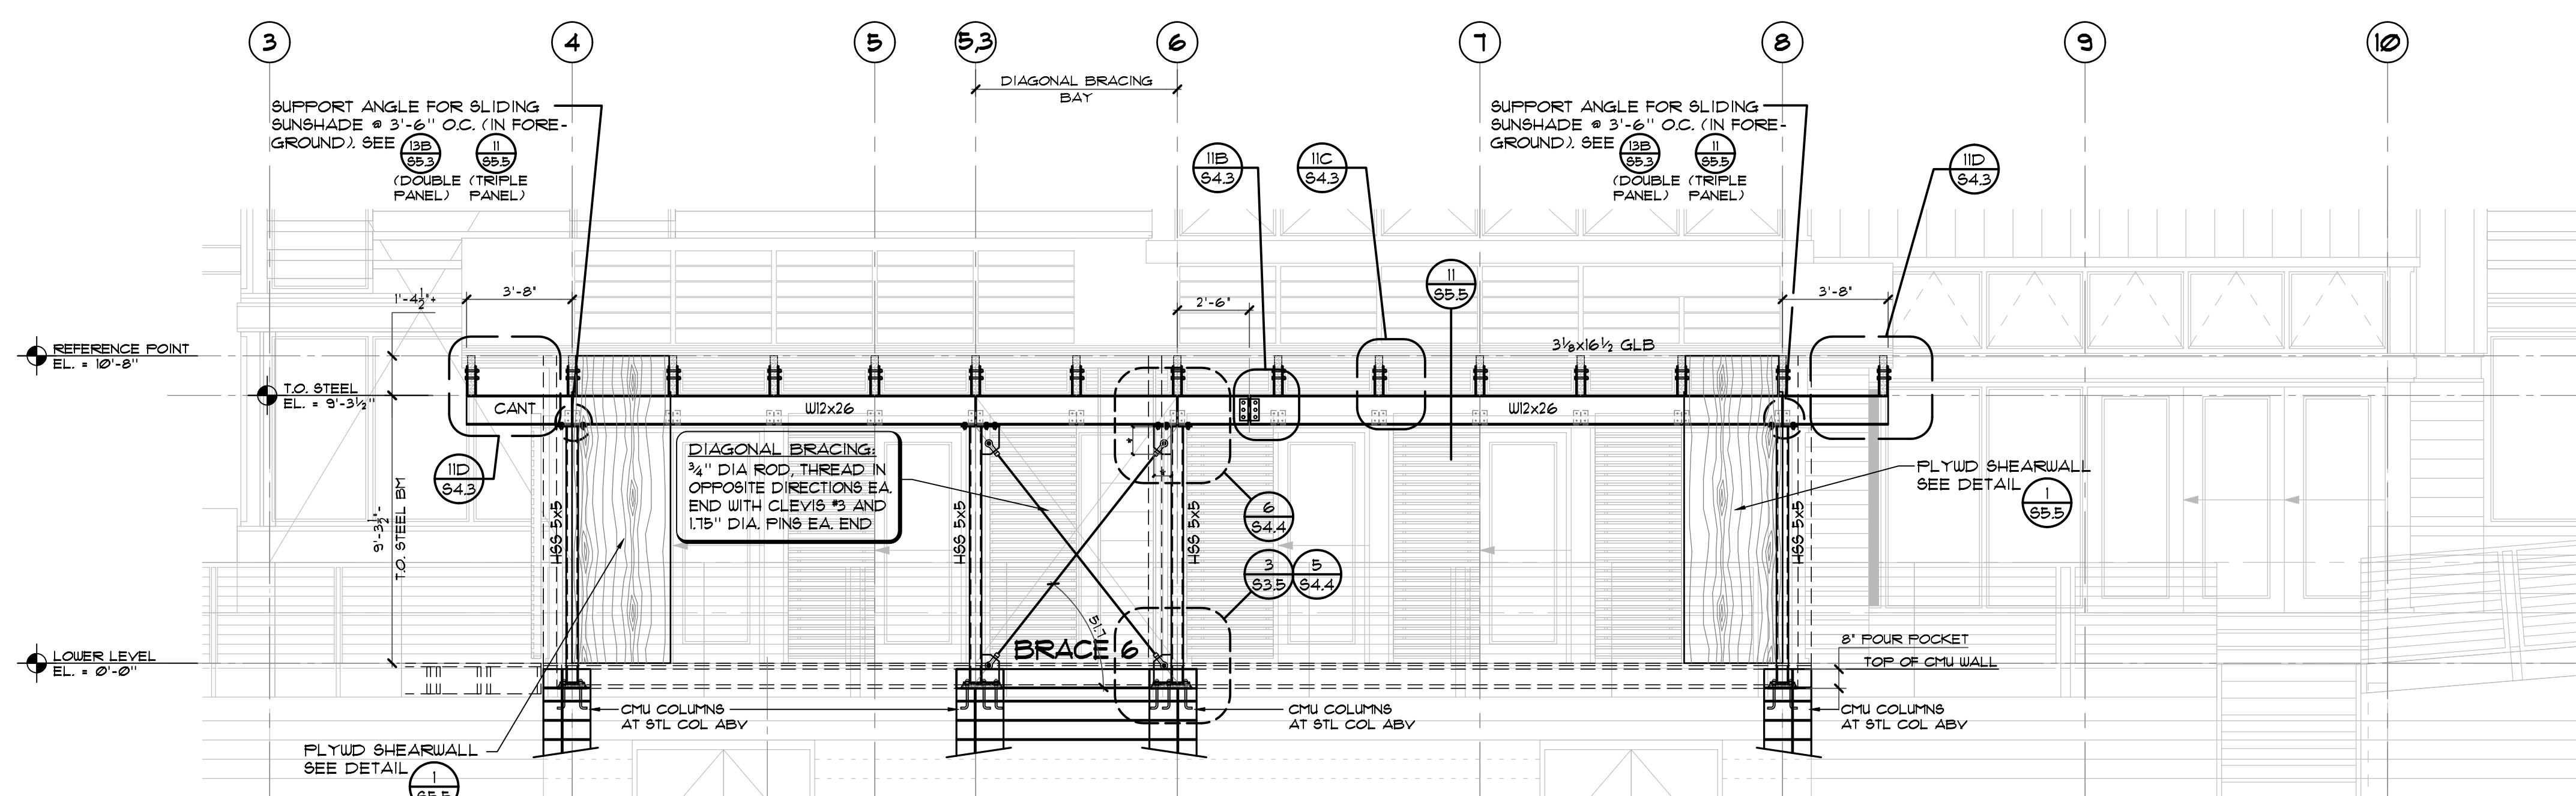

1 FRAMING ELEVATION: STRUCTURAL STEEL FRAMING
ELEVATION ALONG GRID LINE **G**
SCALE: 1/4" = 1'-0"

PERMIT SET	1/19/09
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STEEL FRAMING ELEVATIONS	
PERMIT SET	01-19-09
Drawn by: WTV, RD, KC	Job Number: WVA-28012
Checked by: WTV, RD, KC	Scale: AS NOTED
PERMIT SET	Date: 01/19/2009

**S
4.2**