

| Door No. | Room Name | Door Type | Door Material | Door Finish | Door Width | Door Height | Frame Type | Frame Material | Frame Finish | Head Detail | Jamb Detail | Threshold | Hardware Set | Label | Remarks |
|----------|----------------|-----------|---------------|-------------|------------|-------------|------------|----------------|--------------|-------------|-------------|-----------|--------------|-------|---------|
| 111 | MAUKA HALL | B | ALUM | FACTORY | 3'-0" | 7'-10" | - | ALUM | FACTORY | - | - | - | - | - | - |
| 110 | CONFERENCE | B | WD | FACTORY | 3'-0" | 7'-10" | - | ALUM | FACTORY | - | - | - | - | - | - |
| 109 | DIRECTOR | B | WD | FACTORY | 3'-0" | 7'-10" | - | ALUM | FACTORY | - | - | - | - | - | - |
| 108 | PROJECT RM | B | WD | FACTORY | 3'-0" | 7'-10" | - | ALUM | FACTORY | - | - | - | - | - | - |
| 107 | PROJECT RM | B | WD | FACTORY | 3'-0" | 7'-10" | - | ALUM | FACTORY | - | - | - | - | - | - |
| 106 | MEN | A | WD | FACTORY | 3'-0" | 7'-10" | - | ALUM | FACTORY | - | - | - | - | - | - |
| 105 | JC | A | WD | FACTORY | 3'-0" | 7'-10" | - | ALUM | FACTORY | - | - | - | - | - | - |
| 104 | HATCH | A | WD | FACTORY | 3'-0" | 7'-10" | - | ALUM | FACTORY | - | - | - | - | - | - |
| 103 | WOMEN | A | WD | FACTORY | 3'-0" | 7'-10" | - | ALUM | FACTORY | - | - | - | - | - | - |
| 102 | MONITORING LAB | B | WD | FACTORY | 3'-0" | 7'-10" | - | ALUM | FACTORY | - | - | - | - | - | - |
| 101 | MAUKA HALL | B | ALUM | FACTORY | 3'-0" | 7'-10" | - | ALUM | FACTORY | - | - | - | - | - | - |
| 116 | MAKAI HALL | B | ALUM | FACTORY | 3'-0" | 7'-10" | - | ALUM | FACTORY | - | - | - | - | - | - |
| 115 | MAKAI HALL | B | ALUM | FACTORY | 3'-0" | 7'-10" | - | ALUM | FACTORY | - | - | - | - | - | - |
| 002 | WATER | FENCE | FENCE | - | 3'-0" | - | - | - | - | - | - | - | - | - | - |
| 004 | STORAGE | A | HM | PTD | 3'-0" | 7'-0" | - | HM | PTD | - | - | - | - | - | - |
| 003 | STORAGE | A | HM | PTD | 3'-0" | 7'-0" | - | HM | PTD | - | - | - | - | - | - |
| 001 | ELECTRICAL | A | HM | PTD | 3'-0" | 7'-0" | - | HM | PTD | - | - | - | - | - | - |

1. TO DETERMINE PARTITION TYPE AT DOOR OR VIEW WINDOW REFER TO PLAN SHEETS
2. REFER TO PARTITION TYPES TO DETERMINE OVERALL WIDTH OF FRAME PROFILES
3. REFER TO DOOR AND VIEW WINDOW SCHEDULES TO DETERMINE FRAME TYPE
4. REFER TO FRAME AND VIEW WINDOW TYPES TO DETERMINE PROFILES INVOLVED.
5. ALL HOLLOW METAL FRAMES ARE PAINTED PER SPECIFICATION SECTION 09900
6. PROVIDE ANCHORS TO MASONRY CONSTRUCTION PER SPECIFICATION 08100 FRAME ANCHORS
7. PROVIDE FLOOR ANCHORS FOR EACH JAMB AND MULLION WHICH EXTENDS TO THE FLOOR PER SPECIFICATION SECTION 08100 FRAME ANCHORS
8. GROUT SOLID ALL FRAMES AT MASONRY CONSTRUCTION

NOTES ON WOOD AND STEEL DOORS

1. ALL WOOD DOORS ARE FACTORY FINISHED PER SPECIFICATIONS SECTION 08200
2. ALL STEEL DOORS ARE PAINTED PER SPECIFICATION SECTION 09900
3. UNDERCUT ALL DOORS 1/2" A.F.F. UNLESS OTHERWISE NOTED. COORDINATE WITH MECHANICAL DRAWINGS.

ENERGY LAB

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Architecture
Master Planning
Space Planning
Interior Design

PROJECT MANAGEMENT

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SUSTAINABILITY

Buro Happold Consulting Engineers PC
100 Broadway, 23rd Floor
New York, NY, 10005
212.334.2025 tel

CIVIL ENGINEERING

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STRUCTURAL ENGINEERING


Walter Vorfeld & Associates
10 Uiana Street
Makawao, Maui, HI 96768
808.572.3535 tel
808.573.3616 fax

MECHANICAL ENGINEERING

Hakalau Engineering
PO Box 252
Hakalau, Hawaii 96710
808.961.6206 tel


ELECTRICAL ENGINEERING

Wallace T. Oki, PE, Inc.
808.961.9666 x22

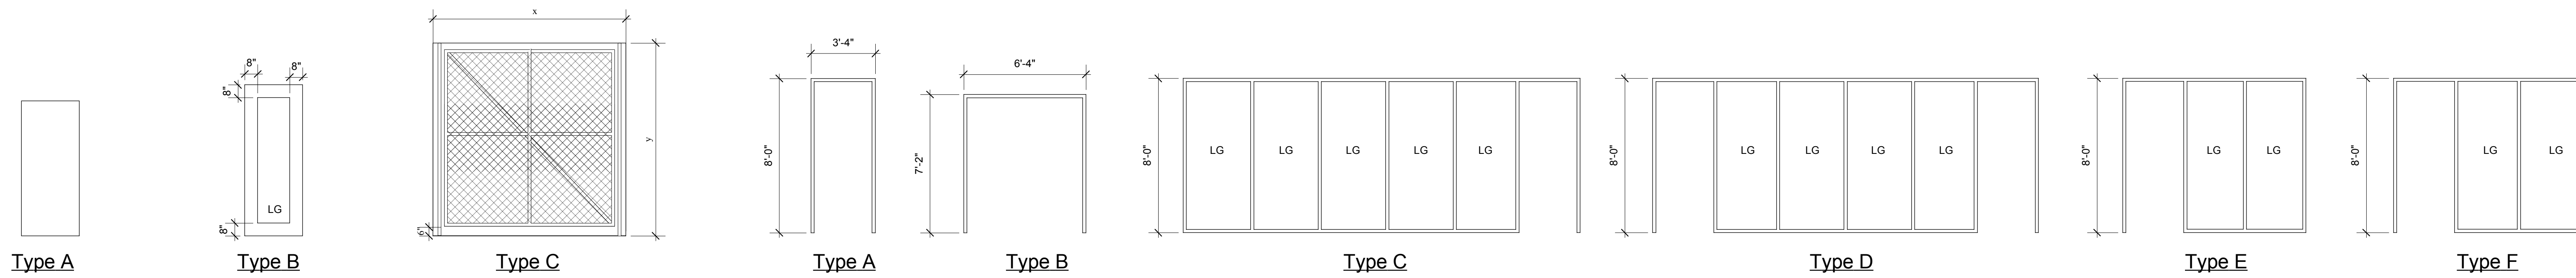


1 DOOR TYPES
Scale: 1/4" = 1'-0"

2 FRAME TYPES
Scale: 1/4" = 1'-0"

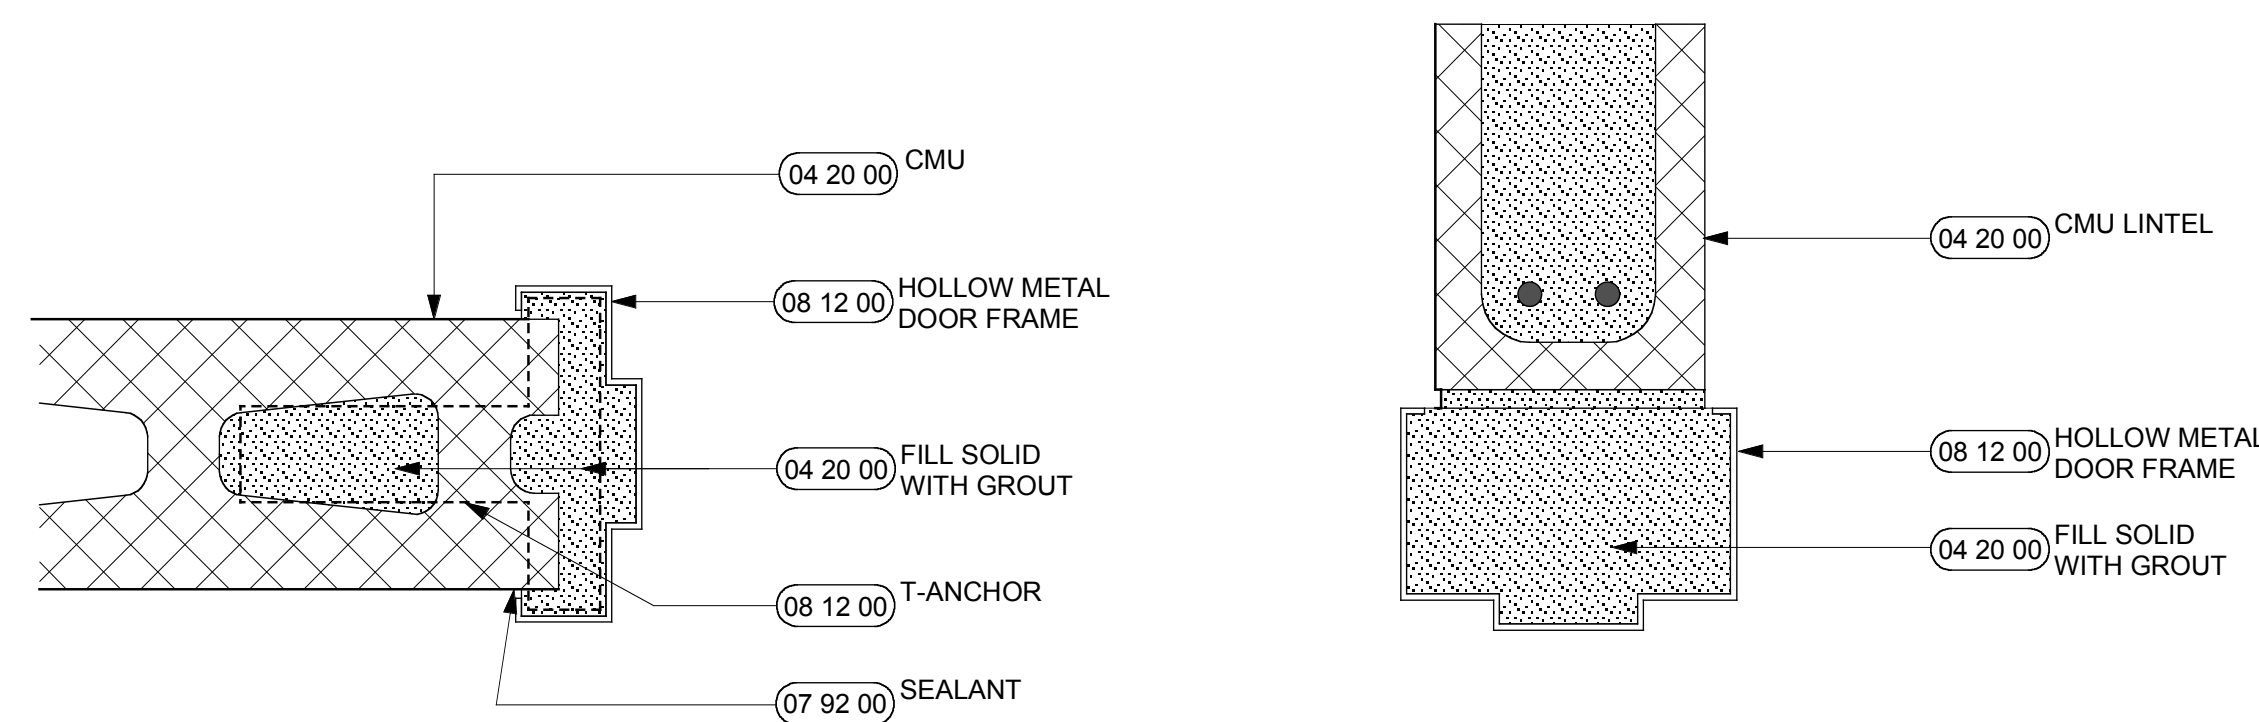


3 JAMB DETAIL 1
Scale: 1/4" = 1'-0"

4 HEAD DETAIL 1
Scale: 1/4" = 1'-0"

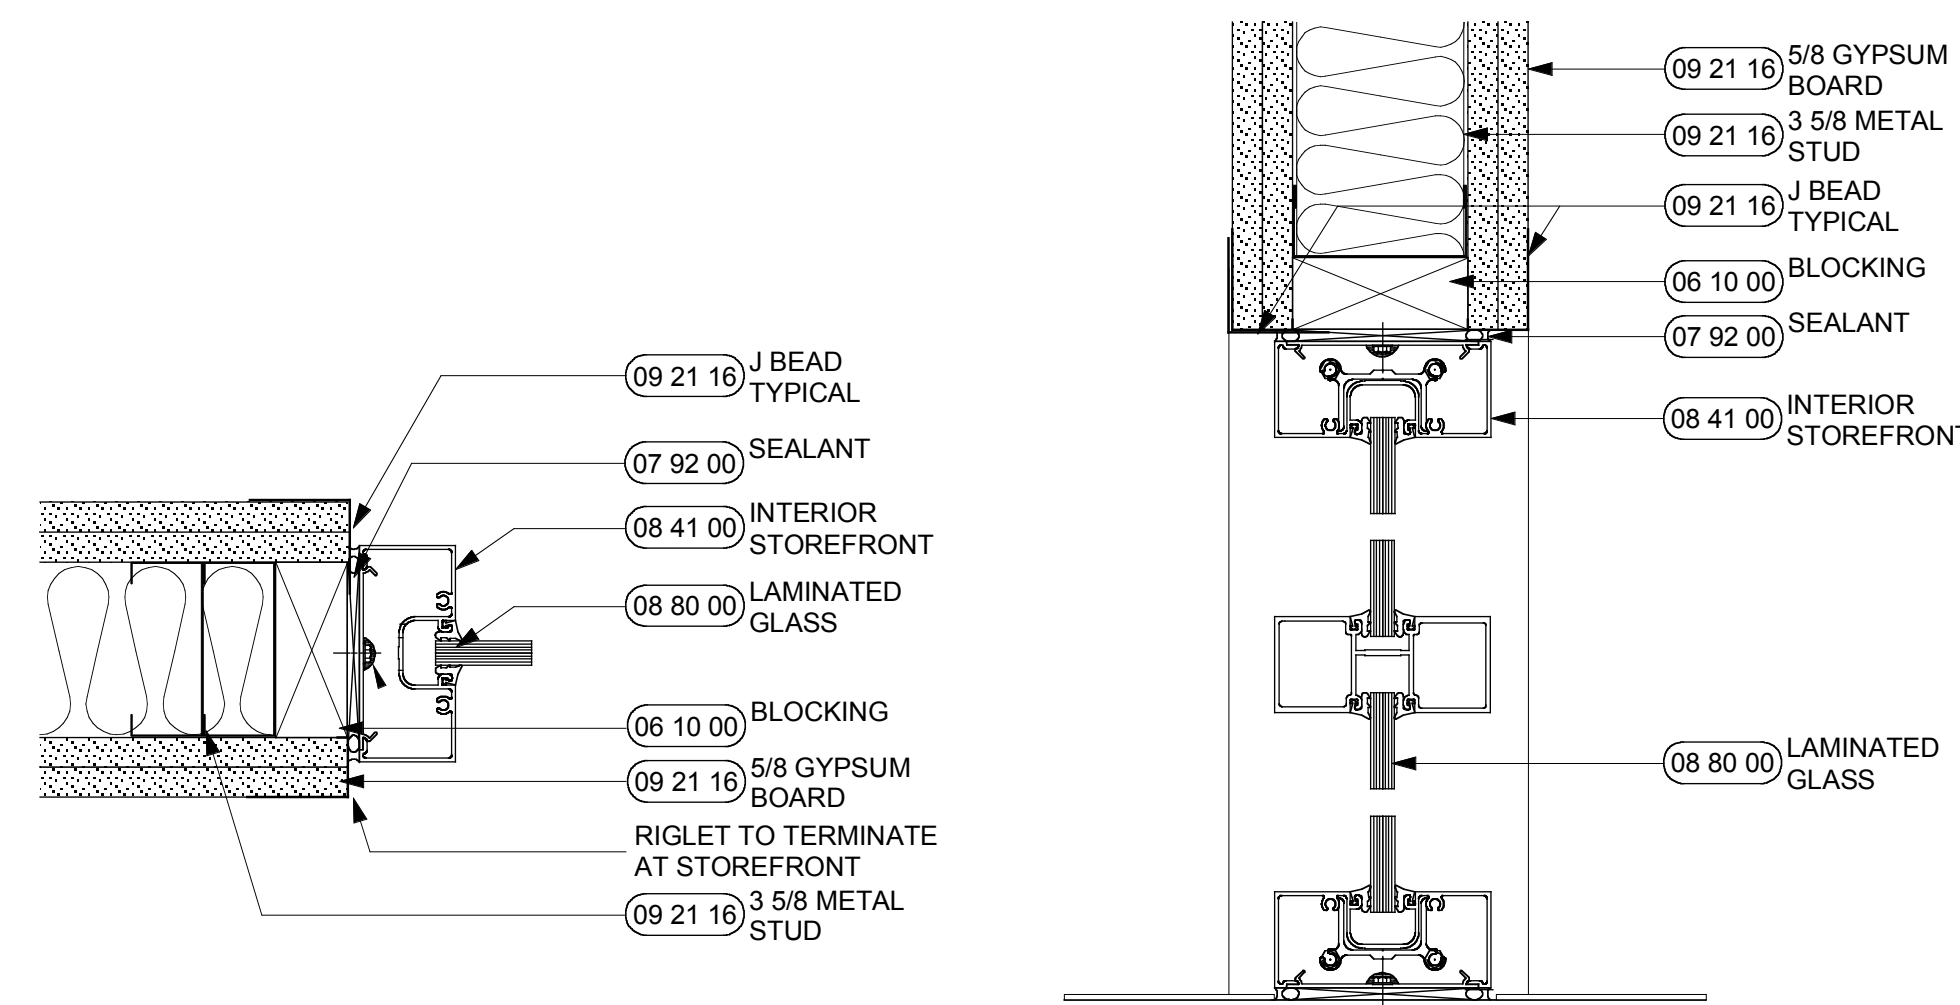

5 JAMB DETAIL 2
Scale: 1/4" = 1'-0"

6 HEAD DETAIL 2
Scale: 1/4" = 1'-0"

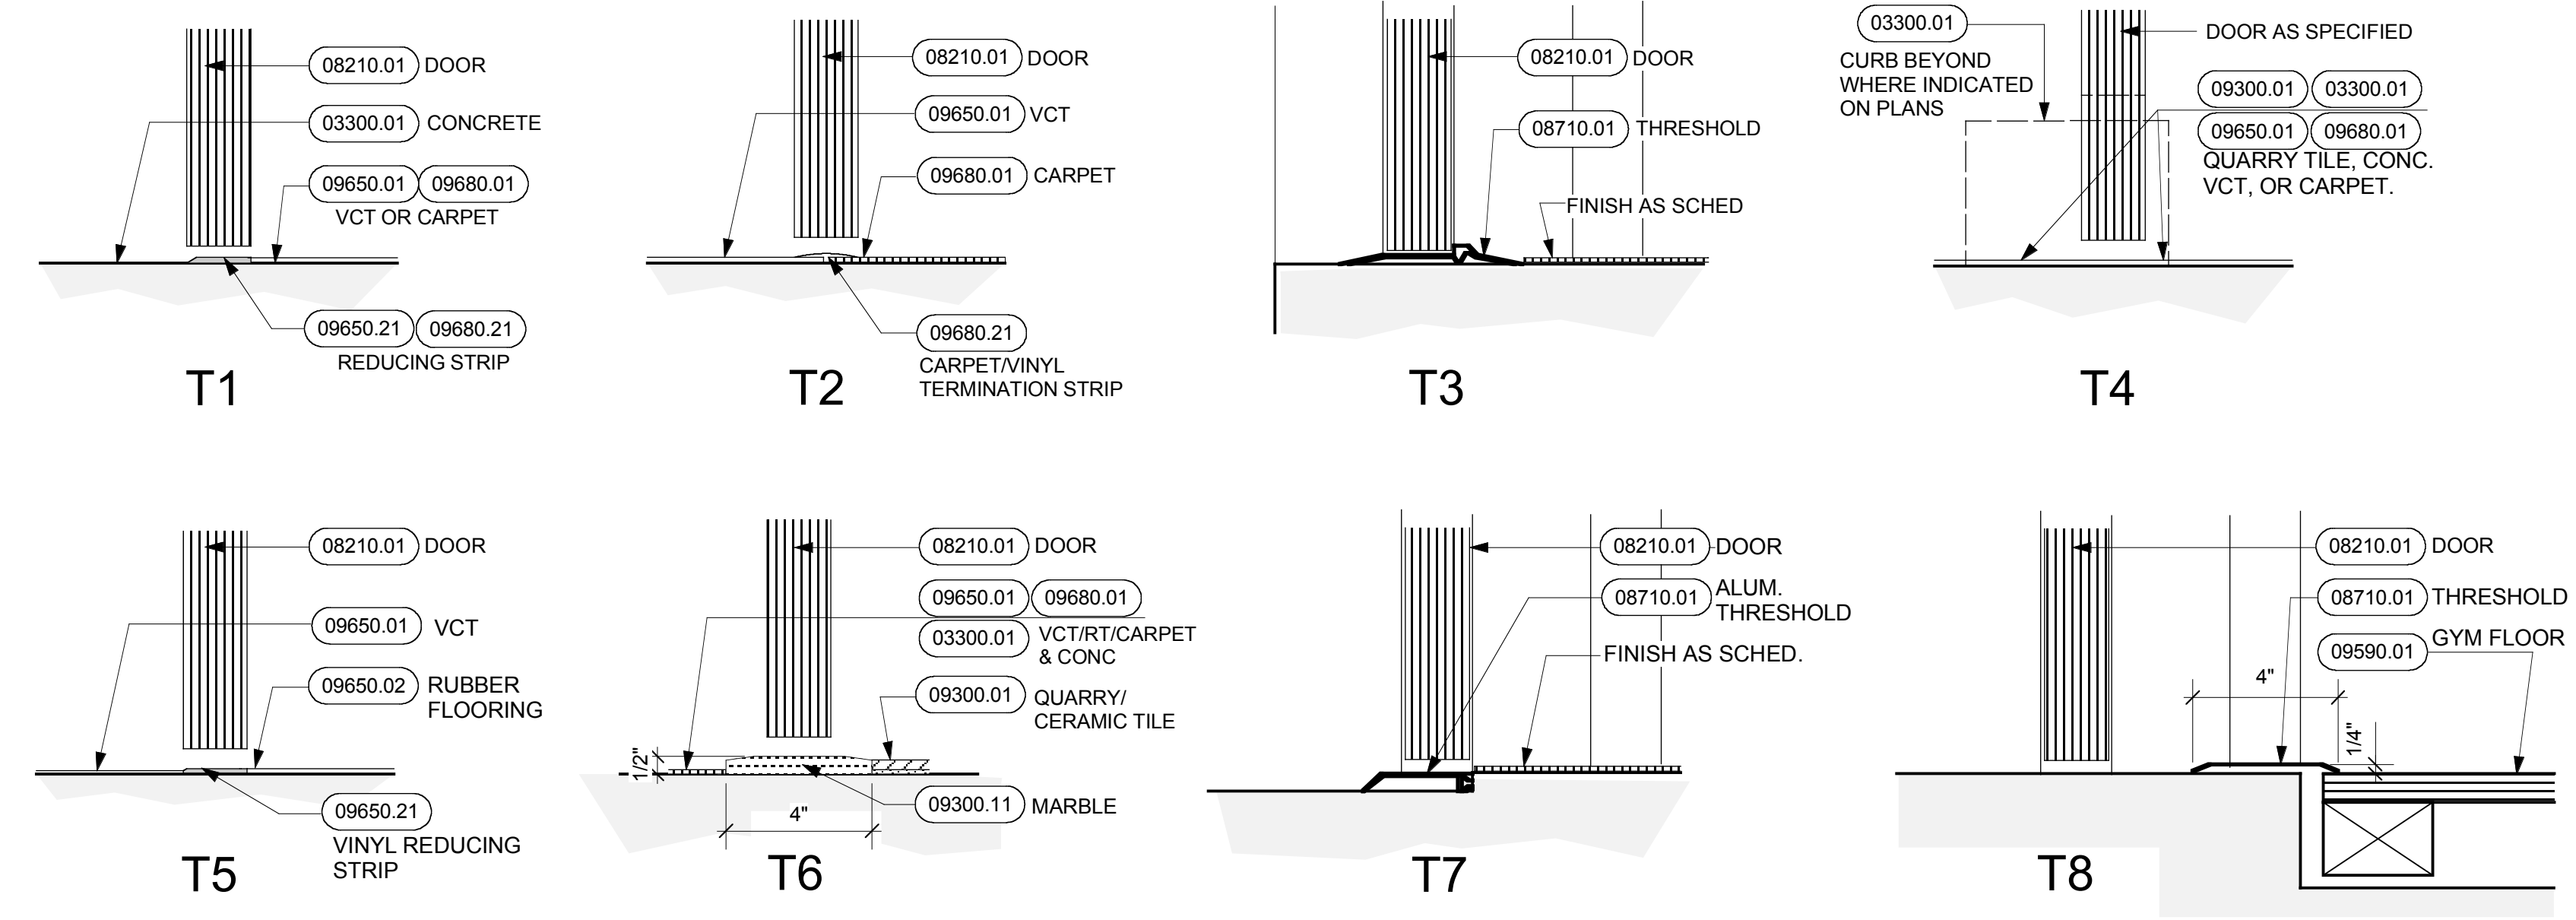

TYPICAL THRESHOLDS AND FLOORING TRANSITIONS

SCALE: 3/4" = 1'-0"

7 TYPICAL THRESHOLD DETAILS
Scale: 1/4" = 1'-0"

INTERIOR STOREFRONT, DOOR SCHEDULE, & DETAILS

Drawn by: CB Job Number: 2804.00
Checked by: Scale: 1/4" = 1'-0"
Plot Date: Issue Date: 11 AUG 08

A
6.1